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Our Ref: 19292

9 July 2020

Catholic Metropolitan Cemeteries Trust  
Level 2/11 Murray Rose Ave,  
Sydney Olympic Park  
NSW 2127

**Attention: Mr David De Angelis**

Dear David,

**RE: PROPOSED CHANGE OF USE OF PART OF GOLF COURSE TO CEMETERY INCLUDING ALTERATIONS, ADDITIONS AND CHANGES TO/NEW ACCESS FROM PARK ROAD – 13-15 PARK ROAD, WALLACIA**

We refer to the letter from Transport for New South Wales dated 27th March 2020.

We note the strips of land X, Y and Z which have been or will be acquired.

In particular however we refer to **Attachment A** to that letter which raised a number of concerns/clarifications relating to the design of the accesses to the subject site.

TfNSW originally commented that “*Swept path movements of the longest vehicle (including garbage trucks, building maintenance vehicles and removalists) entering and exiting the subject site, as well as manoeuvrability through the site, are to be provided and shall be in accordance with AUSTROADS*”.

TfNSW now note that “*the provided turn paths for an 8.8m vehicle provided are acceptable. Consideration should be given to larger vehicles (as a checking vehicle) for during construction it is likely 19m semi-trailers will be accessing the sites. In addition, the swept paths on Figure 9 depict a vehicle accessing/egressing the driveway from the wrong side of the road. Therefore, TfNSW requests updated swept paths to be provided which include a 19m checking vehicle and the swept paths in Figure 9 are to be flipped to the correct side of the road*”.

**WSP has now completed updated more detailed drawings taking these matters into consideration and these are attached at Appendix A**

**TPPP has undertaken swept paths on these new plans and there are contained at Appendix B.**

TfNSW originally commented "Sight distances from the proposed vehicular crossings to vehicles on Park Road are to be in accordance with the Austroads Guide to Road Design: Part 4A: Unsignalised and Signalised Intersections (Section 3 – Sight Distance) and AS2890. Vegetation and proposed landscaping/fencing must not hinder sight lines to and from the vehicular crossings to motorists, pedestrians and cyclists. It is noted that the current driveway design does not appear to comply with the sight distance requirements.

TfNSW now say "The sight distance checks provided for Safe Intersection Sight Distance (SISD) are deemed satisfactory".

**TPPP note that this issue is now addressed.**

#### **Entrance A Nepean Gardens**

TfNSW originally commented "There is a 60 to 80km/h change in speed limit in the same location as the proposed CHR. Vehicles will either be decelerating from 80 to 60km/h (design speed 90 to 70) or accelerating from 60 to 80km/h and this may influence a drivers ability to select a gap to turn into or out of the new entrance. Consideration should be made to relocating the entrance away from the speed limit change. In NSW, TfNSW is responsible for the setting and signposting of safe and appropriate speed limits in accordance with the NSW Speed Zoning Guidelines".

TfNSW now say that they "would support the speed zone change being shifted eastwards to increase safety at the intersection. TfNSW requires that the applicant provides a separate signage plan (inclusive of dimensions) for the speed zone signage, indicating where the sign is proposed to be moved towards, for TfNSW to provide approval, pending determination of this development. However, the right turn bay design is still required to be designed for an 80km/h design speed.

**TPPP state that the current WSP design for the right turn bay into the cemetery access is designed for an 80km/h speed. The current plans contained at Appendix A also show the proposed relocation of the speed zone signage.**

TfNSW originally noted that "there is a crest-curve combination immediately to the west of the proposed CHR location. Sight distance will need to be assessed for vehicles exiting the development to ensure compliance. If sight distance isn't met, the access may need to be moved/mitigation measures implemented. The applicant is to show sight distance calculations around the bend.

TfNSW now say that "as per the abovementioned comment 2, the SISD has been checked for the intersection and is deemed satisfactory. However, to further improve safety, TfNSW preference would be to move the intersection further to the east i.e. further away from the crest/curve combination".

**At this stage TPPP notes that the SISD is satisfactory and does not intend therefore to relocate the intersection.**

TfNSW originally stated that "The horizontal alignment at the tie-ins is poor- it needs to be reviewed and redesigned to comply with Austroads guidelines. The current tie-ins shown will not be accepted".

TfNSW now say that "The tie-ins provided are improved from the previous submission. However more refinement will be required with detailed civil plans, pending determination of this development".

**TTPP note that the more detailed plans provided by WSP are adequate for the assessment of the project but there may be some refinement needed when the final detailed civil plans are submitted. This is not unusual and it is expected that TfNSW will recommend appropriate conditions should approval be granted.**

TfNSW originally said that "there are no shoulders on the northern side of Park Road. This means there is no room for left turning vehicles to decelerate into the access on road pavement. In this regard a left turn deceleration lane is to be provided.

TfNSW now say "Noted that the shoulders have now been provided"

**TTPP note that this issue is now resolved**

#### Entrance C – Wallacia Country Club

TfNSW originally noted that "The CHR is extremely short which does not comply with Austroads Guidelines".

TfNSW now say that "The updated CHR treatment provided is a compliant design and is acceptable, however it is noted that this conflicts with Driver Avenue. Therefore a "No Right Turn" ban will need to be implemented for vehicles turning right out of Driver Avenue onto Park Road. The applicant will be required to undertake consultation with affected residents and TfNSW Network & Safety Section Brana Ravichelvan at [brana.ravichelvan@transport.nsw.gov.au](mailto:brana.ravichelvan@transport.nsw.gov.au) about this movement restriction, pending determination of this development.

**The submitted plans show that the right turn ban from Driver Avenue has been provided.**

TfNSW has noted that "the horizontal alignment at the tie-ins is poor and is to be redesigned to comply with Austroads guidelines. The current tie-ins shown will not be accepted.

TfNSW now say that "the tie-ins provided are improved from the previous submission. However more refinement will be required with detailed civil plans, pending determination of this development."

**TTPP note that the more detailed plans provided by WSP are adequate for the assessment of the project but there may be some refinement needed when the final detailed civil plans are submitted. This is not unusual and it is expected that TfNSW will recommend appropriate conditions should approval be granted.**

TfNSW originally noted that "In addition to the above the proposal appears to utilise the existing shoulder, TfNSW would not support the removal of the shoulder.

TfNSW now say that "To provide the shoulder, widening is proposed to be adjacent to the club i.e. northern side of the road. There are a number of large electricity poles behind the existing kerb which may influence where the widening is proposed. There is currently a wide

road reserve on the southern side of the road which could be utilised, subject to a satisfactory design being produced. Therefore, TfNSW requests plans to be updated to show this option.

**The latest plans show the widening to the south.**

TfNSW originally noted that “the pedestrian refuge is located directly to the west of the entrance. Swept paths (of the largest vehicle) are to be provided which show that a vehicle can complete the turn into the westbound lane and stop at the refuge should a pedestrian already be crossing the road.


TfNSW now say “Noted, updated swept paths indicate a vehicle is able to complete the turn prior to the pedestrian refuge”.

**TTPP say that this issue is now resolved.**

We have therefore appended a set of updated drawings to this letter which we believe have now addressed the TfNSW concerns.

We trust the above is to your satisfaction. Should you have any queries regarding the above or require further information, please do not hesitate to contact the undersigned on 8437 7800.

Yours sincerely,

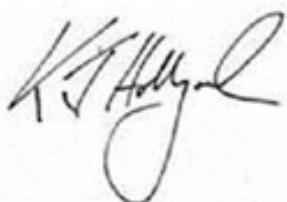


**Ken Hollyoak**  
**Director**

# Appendix A

## WSP Plans

## REFER C7.02 FOR CONTINUATION


## PRELIMINARY - NOT FOR CONSTRUCTION

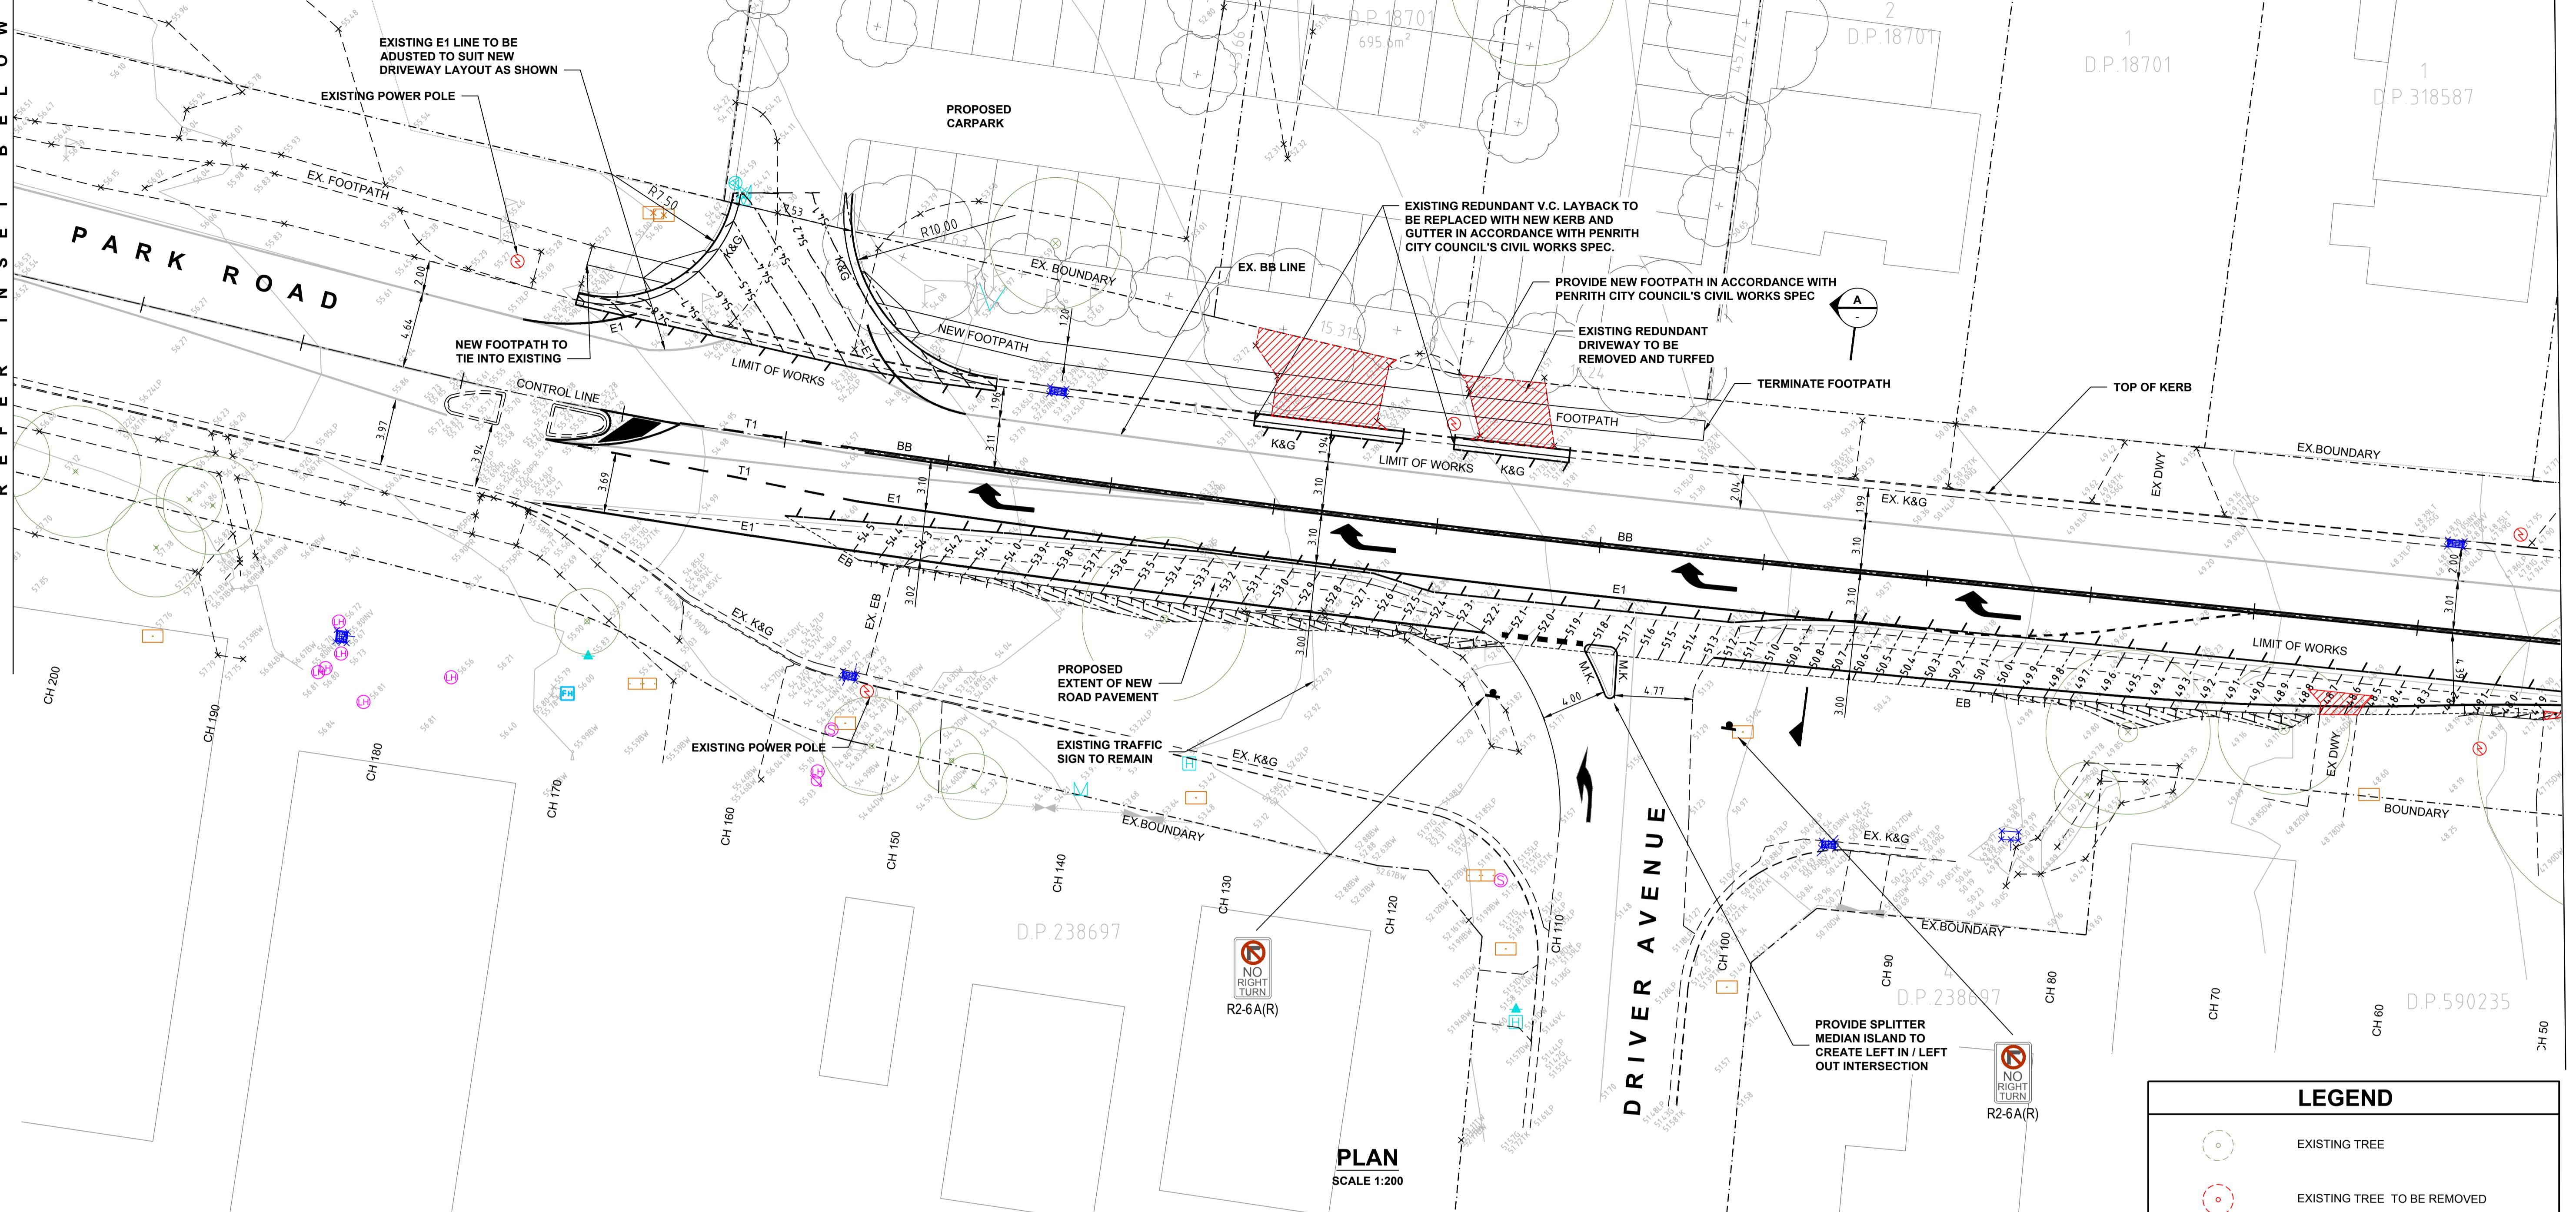

Xrefs: X-593601-D(E\_Design\_X-593601-SU\_Ground\_X-593601-DE\_Concrete\_X-487500-AR\_Site Plan  
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Old File: /593601/DesignAutocad/DesignC/25DA/C7.01 External Works Plan.dwg  
Version: 1, Version Date: 21/08/2020

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NORTH

REVISION

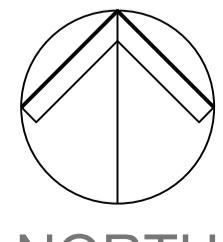AMENDMENT

DATE

REVISION

AMENDMENT

DATE

CLIENT

PROJECT

PREPARED BY

TITLE

CMCT

NEPEAN GARDENS

EXTERNAL WORKS PLAN

SHEET 1

SCALE AS SHOWN

DRAWN J.W.

DESIGNED N.Q.

CHECKED L.Sh.

APPROVED M.C.

JOB No.

DRAWING No.

ISSUE

5325001

C7.01

2

DATE

JUNE 2020

STATUS


DEVELOPMENT APPLICATION

# PRELIMINARY - NOT FOR CONSTRUCTION




X:\Users\jack\Downloads\X-5936001-TB\_AIH-X-5936001-DE\_Park Rd Control Line.X-5936001-SU\_Ground.X-5936001-DE\_Contours.X-667500-AR\_Site Plan  
Plot Date: 11.06.2020@16:00:15 Login Name: jack Cad File: T:\5936001\1D\drawing\AutoCAD\Civil\Design\Civil\External Works Plan.dwg

Set II. 28

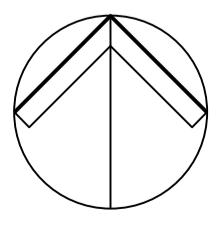


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PLAN
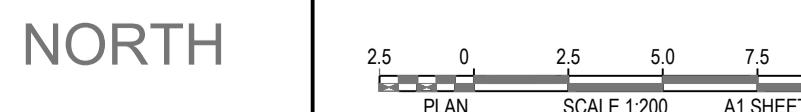
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SCALE 1:20

# CLIENT CMCT PROJECT

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**Warren Smith & Partners Pty Ltd**  
Level 9, 233 Castlereagh St, Sydney 2000 NSW Australia  
02 9299 1312 [wsp@warrensmith.com.au](mailto:wsp@warrensmith.com.au)  
[www.warrensmith.com.au](http://www.warrensmith.com.au) ABN 36 300 430 126

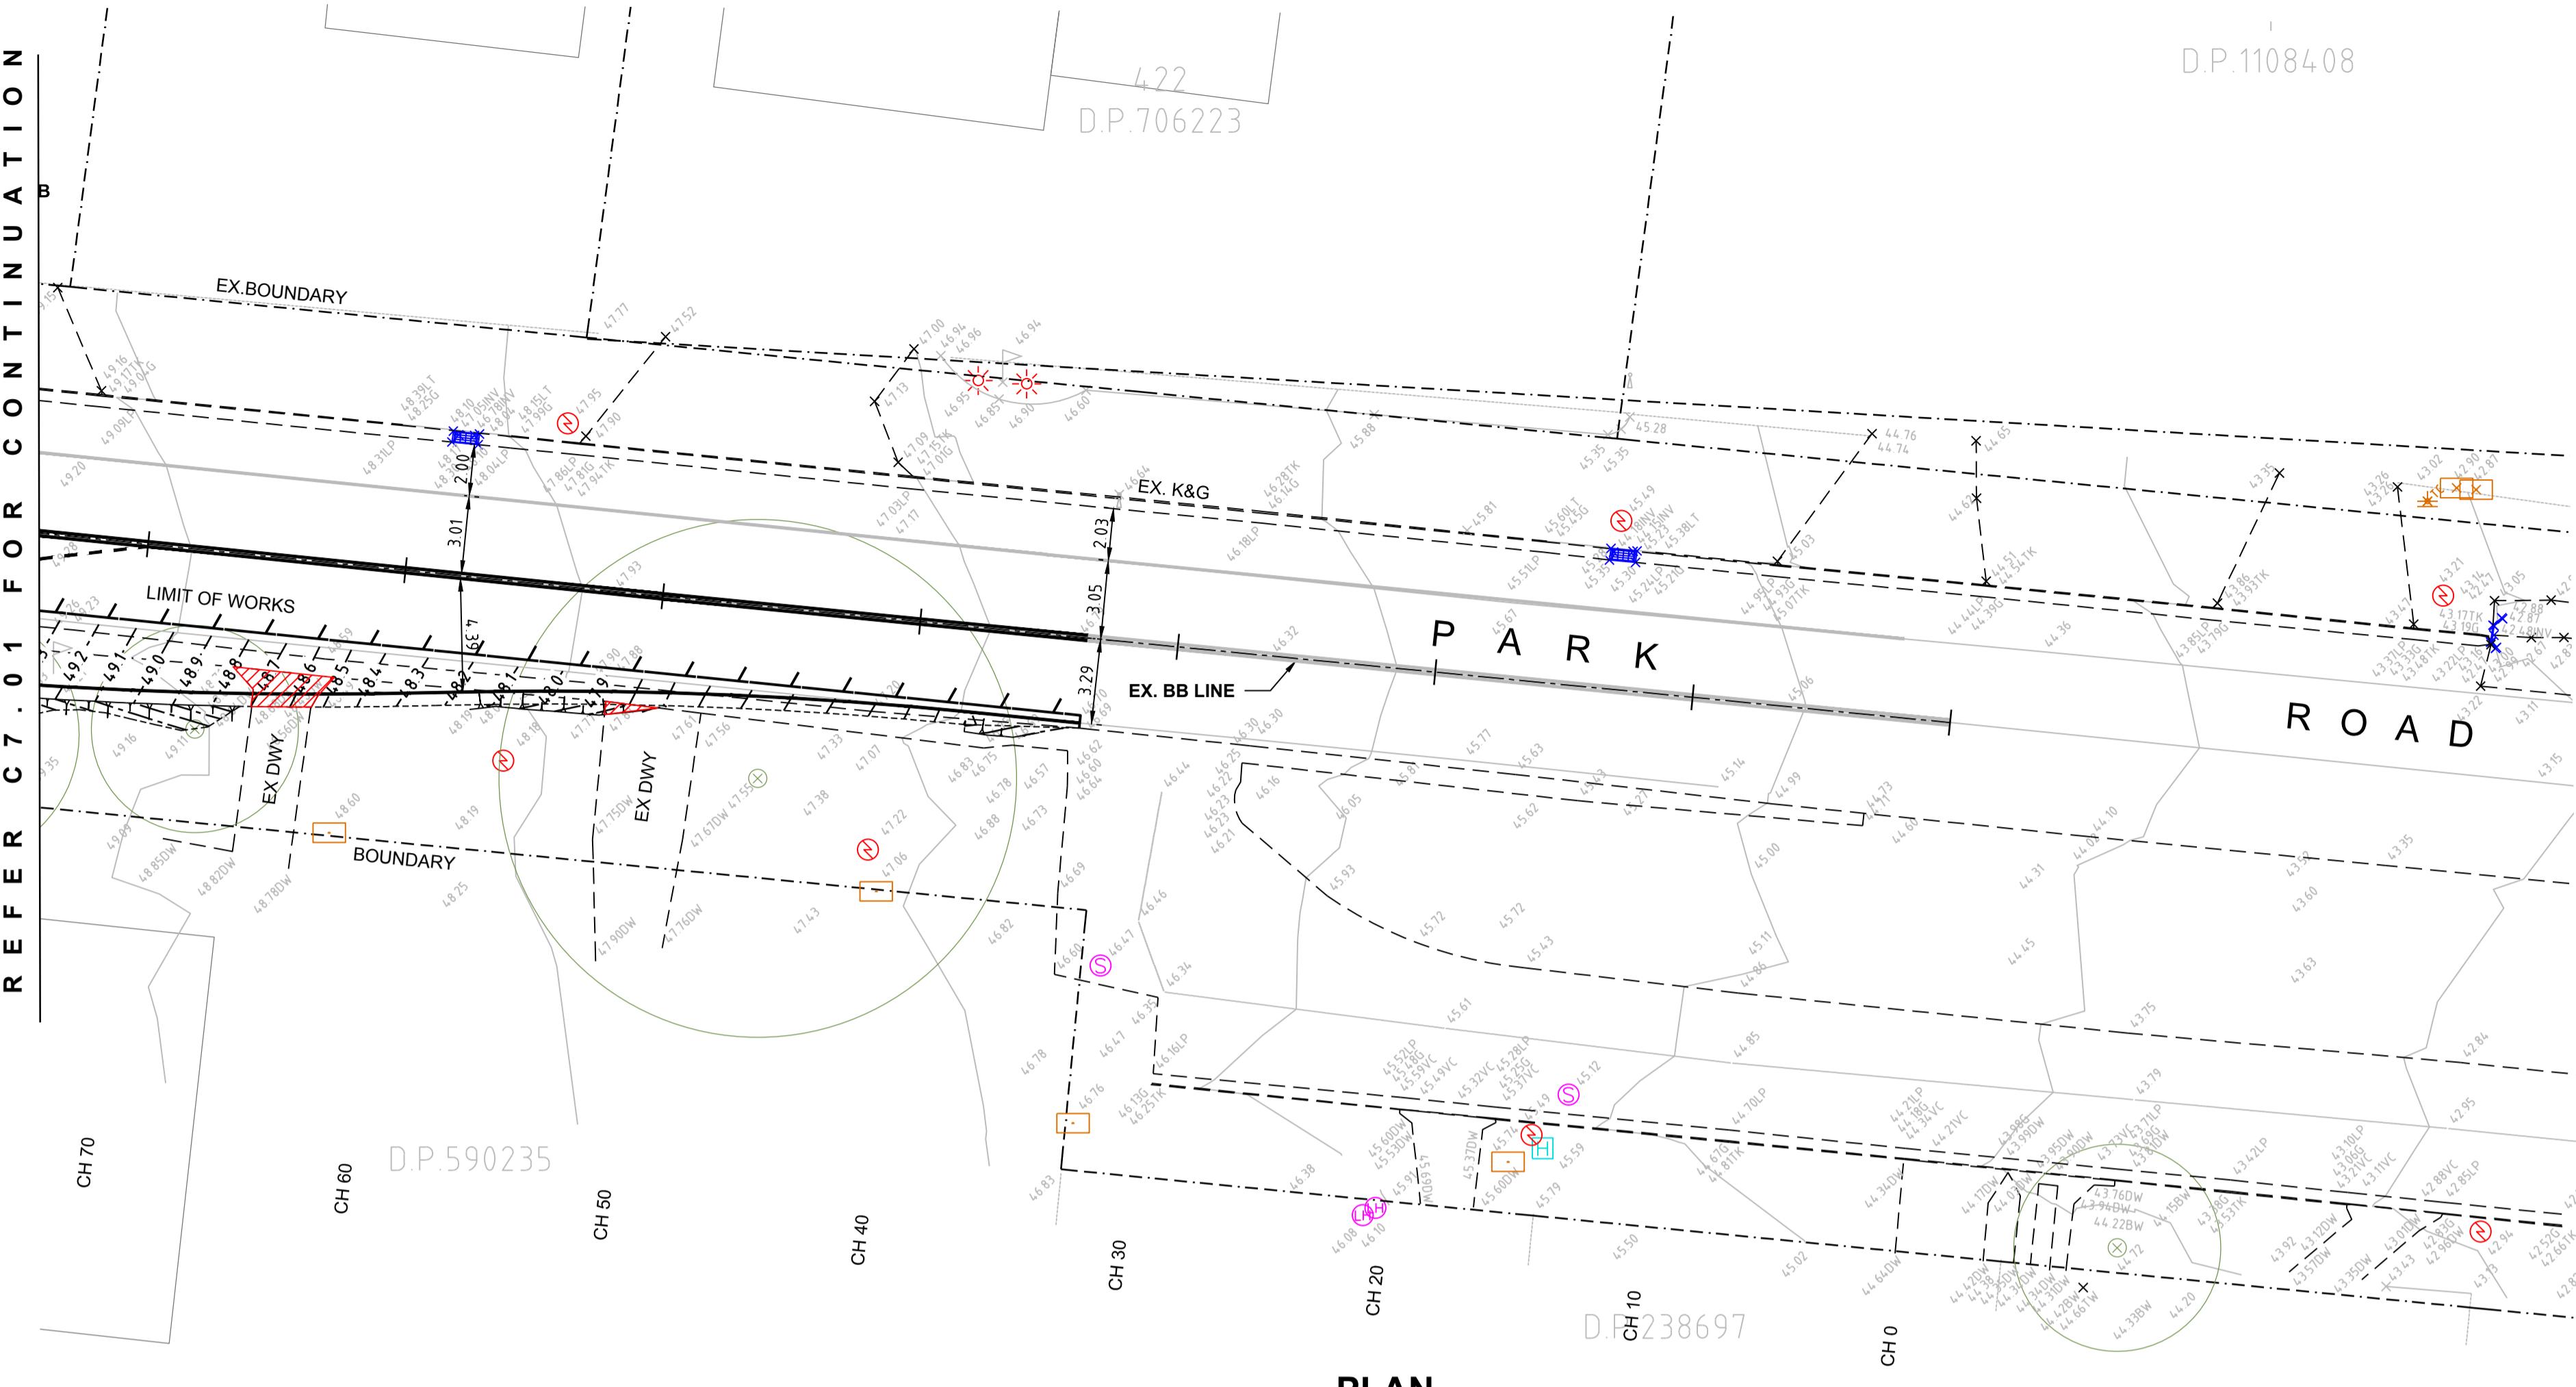
**CONSULTING ENGINEERS**  
■ Hydraulic Services ■ Fire Services  
■ Civil Services ■ Sydney Water Accredited Water  
Servicing Co-ordinator and Designer

**SERVING THE CONSTRUCTION INDUSTRY  
SINCE 1981**

# EXTERNAL WORKS PLAN


# SHEET 2

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OB No.  <b>5325001</b>	DRAWING No.  <b>C7.02</b>	ISSUE  <b>2</b>	
DATE  <b>JUNE 2020</b>	STATUS  <b>DEVELOPMENT APPLICATION</b>		

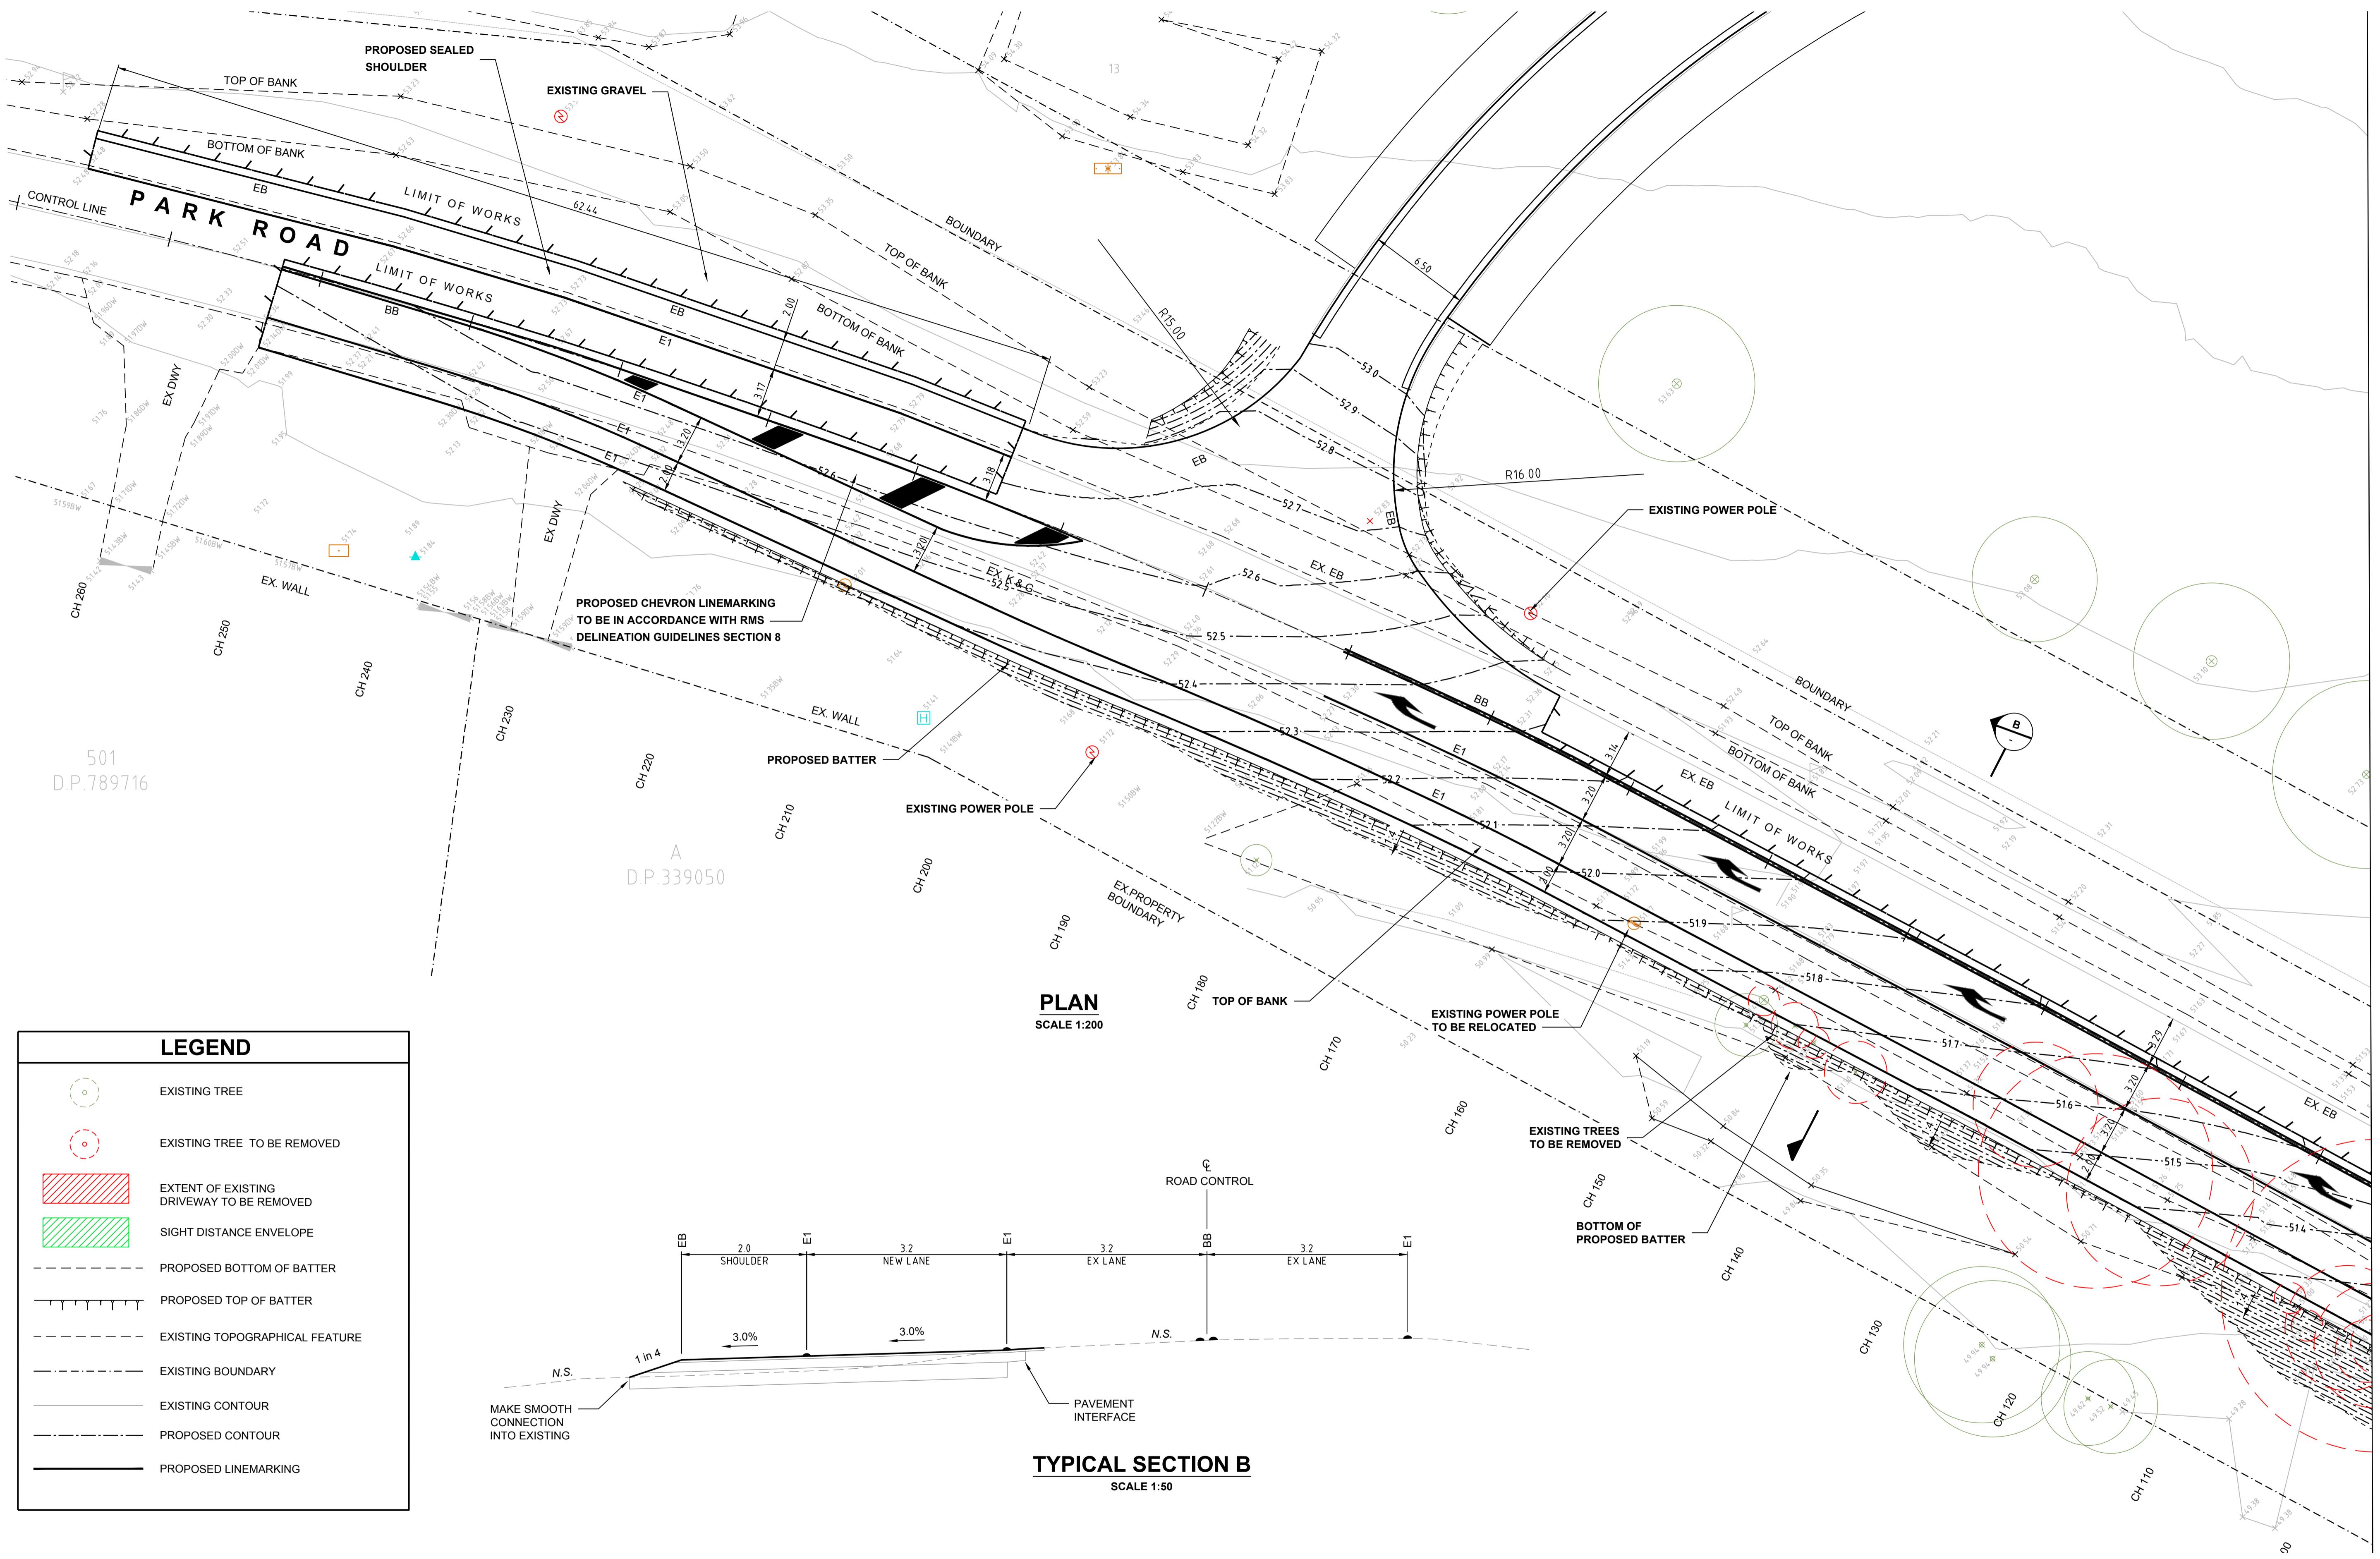

REVISION	AMENDMENT	DATE	REVISION	AMENDMENT	DATE	CLIENT	PREPARED BY	TITLE
1	ISSUE FOR INFORMATION	05/06/20				CMCT	Warren Smith & Partners Pty Ltd Level 9, 233 Castlereagh St, Sydney 2000 NSW Australia 02 9299 1312 wsp@warrensmith.com.au <a href="http://www.warrensmith.com.au">www.warrensmith.com.au</a> ABN 36 300 430 126	EXTERNAL WORKS PLAN SHEET 3
						PROJECT	CONSULTING ENGINEERS ■ Hydraulic Services ■ Fire Services ■ Civil Services ■ Sydney Water Accredited Water Serving Co-ordinator and Designer SERVING THE CONSTRUCTION INDUSTRY SINCE 1981. 	SCALE AS SHOWN DRAWN J.W. DESIGNED N.Q. CHECKED L.Sh. APPROVED M.C.
						NEPEAN GARDENS	JOB No. 5325001 DRAWING No. C7.03 ISSUE 2	DATE JUNE 2020 STATUS DEVELOPMENT APPLICATION

# PRELIMINARY - NOT FOR CONSTRUCTION

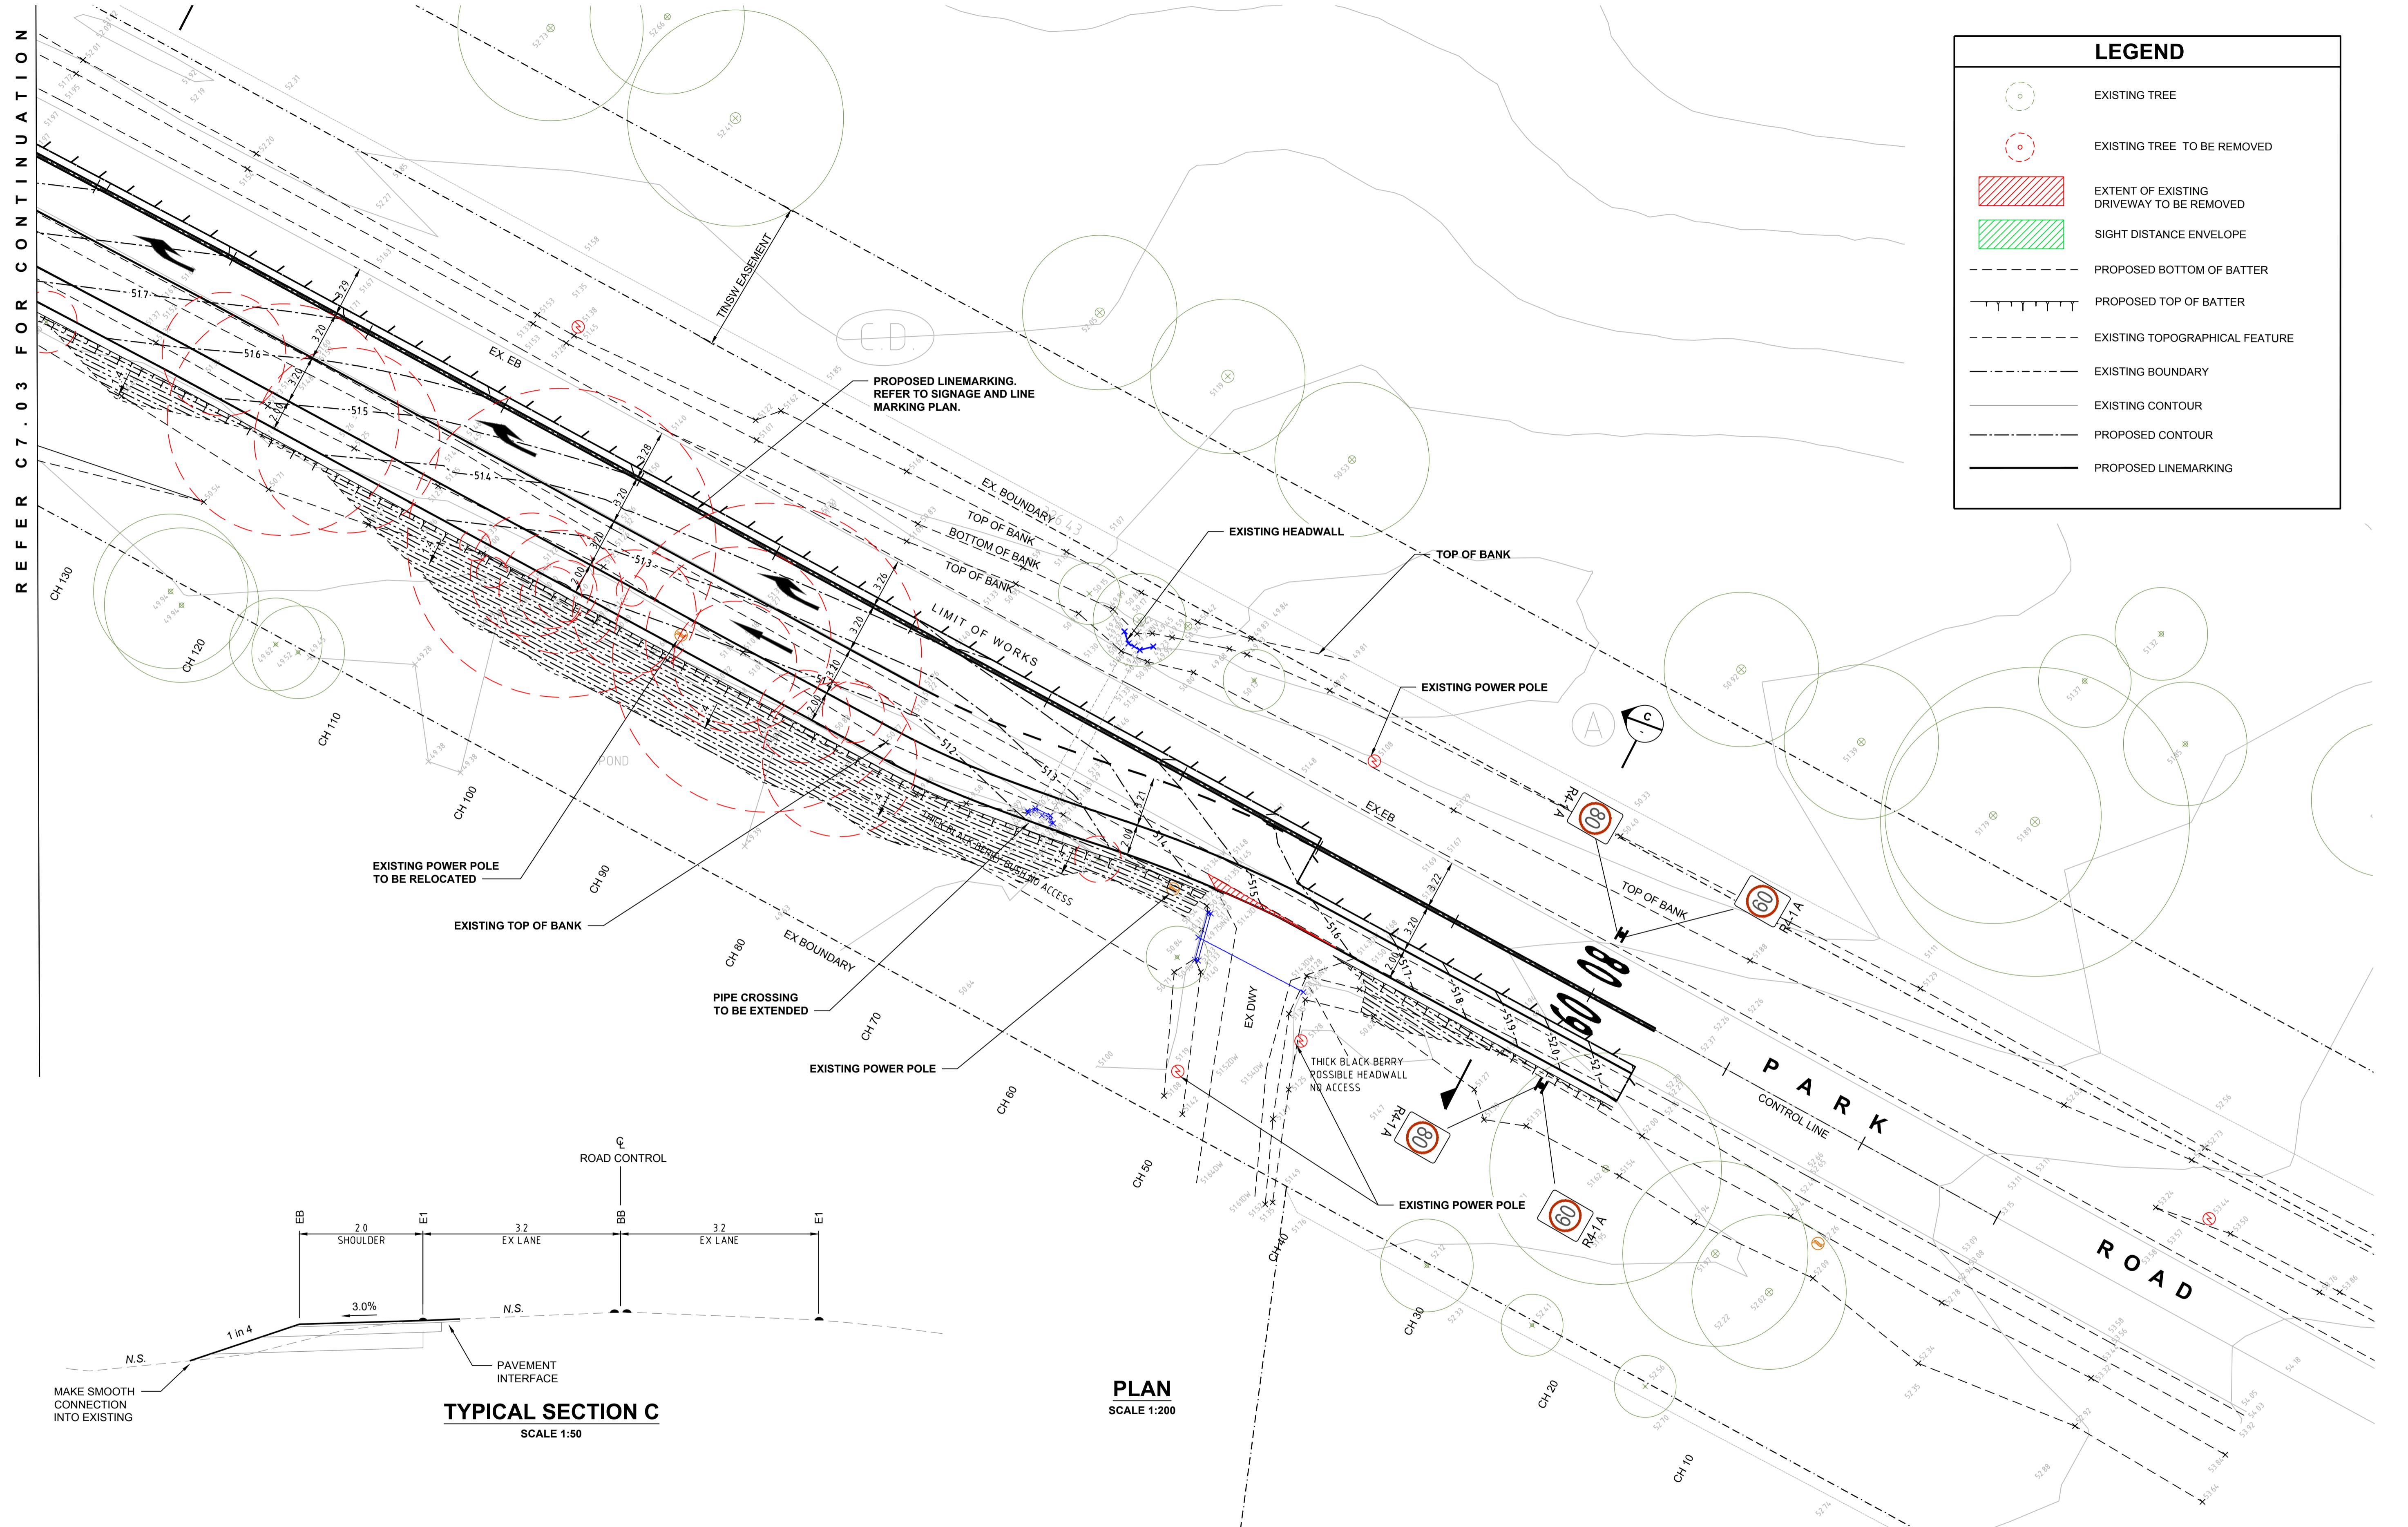


DO NOT SCALE FROM DRAWINGS. CHECK & VERIFY ALL DIMENSIONS & LEVELS BEFORE COMMENCEMENT OF ANY WORK.		PROJECT		CLIENT		PREPARED BY		TITLE	
THIS DRAWING IS NOT TO BE COPIED IN PART OR WHOLE WITHOUT WRITTEN PERMISSION FROM WARREN SMITH AND PARTNERS.		NEPEAN GARDENS		CMCT		Warren Smith & Partners Pty Ltd Level 9, 233 Castlereagh St, Sydney 2000 NSW Australia 02 9299 1312 wsp@warrensmith.com.au <a href="http://www.warrensmith.com.au">www.warrensmith.com.au</a> ABN 36 300 430 126		EXTERNAL WORKS PLAN SHEET 4	
REF ID: X-589001-DE_Park Rd Control Line X-589001-SU_Ground X-589001-DE_Concrete X-4875000-AR_Site Plan Print Date: 10/08/2020 15:44:46 Job Name: Park Rd Control Line X-589001-DE Old File: 15836010.Dwg AutoCAD Drawing		CONSULTING ENGINEERS		Warren Smith & Partners Pty Ltd Level 9, 233 Castlereagh St, Sydney 2000 NSW Australia 02 9299 1312 wsp@warrensmith.com.au <a href="http://www.warrensmith.com.au">www.warrensmith.com.au</a> ABN 36 300 430 126		SCALE AS SHOWN DRAWN J.W. DESIGNED N.Q. CHECKED L.Sh. APPROVED M.C.		DRAWING No: 5325001 C7.04 2	
Version: 1/08/2020 Version Date: 21/08/2020		JOB No:		DATE JUNE 2020		STATUS DEVELOPMENT APPLICATION			


# Appendix B

## Swept paths of WSP Plans

## VEHICLE ENTERING

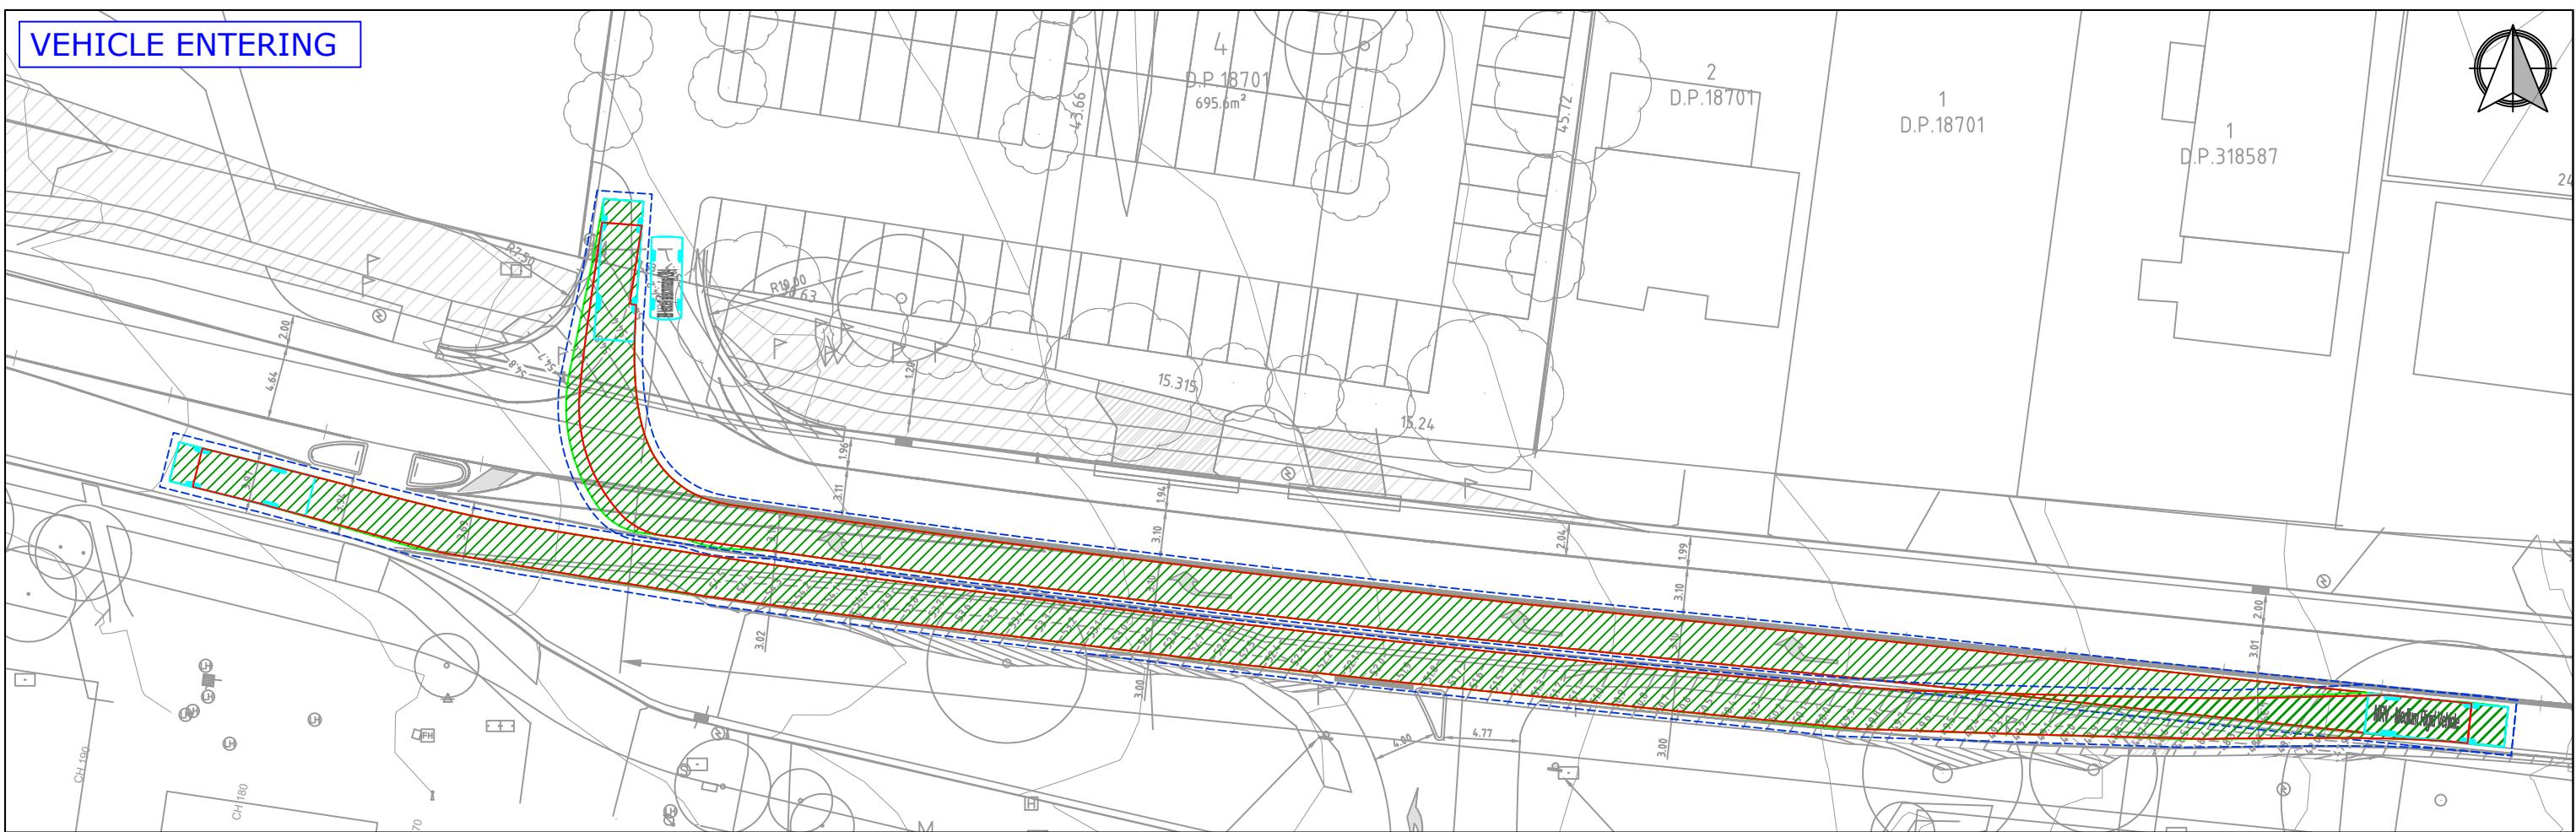


## VEHICLE EXITING

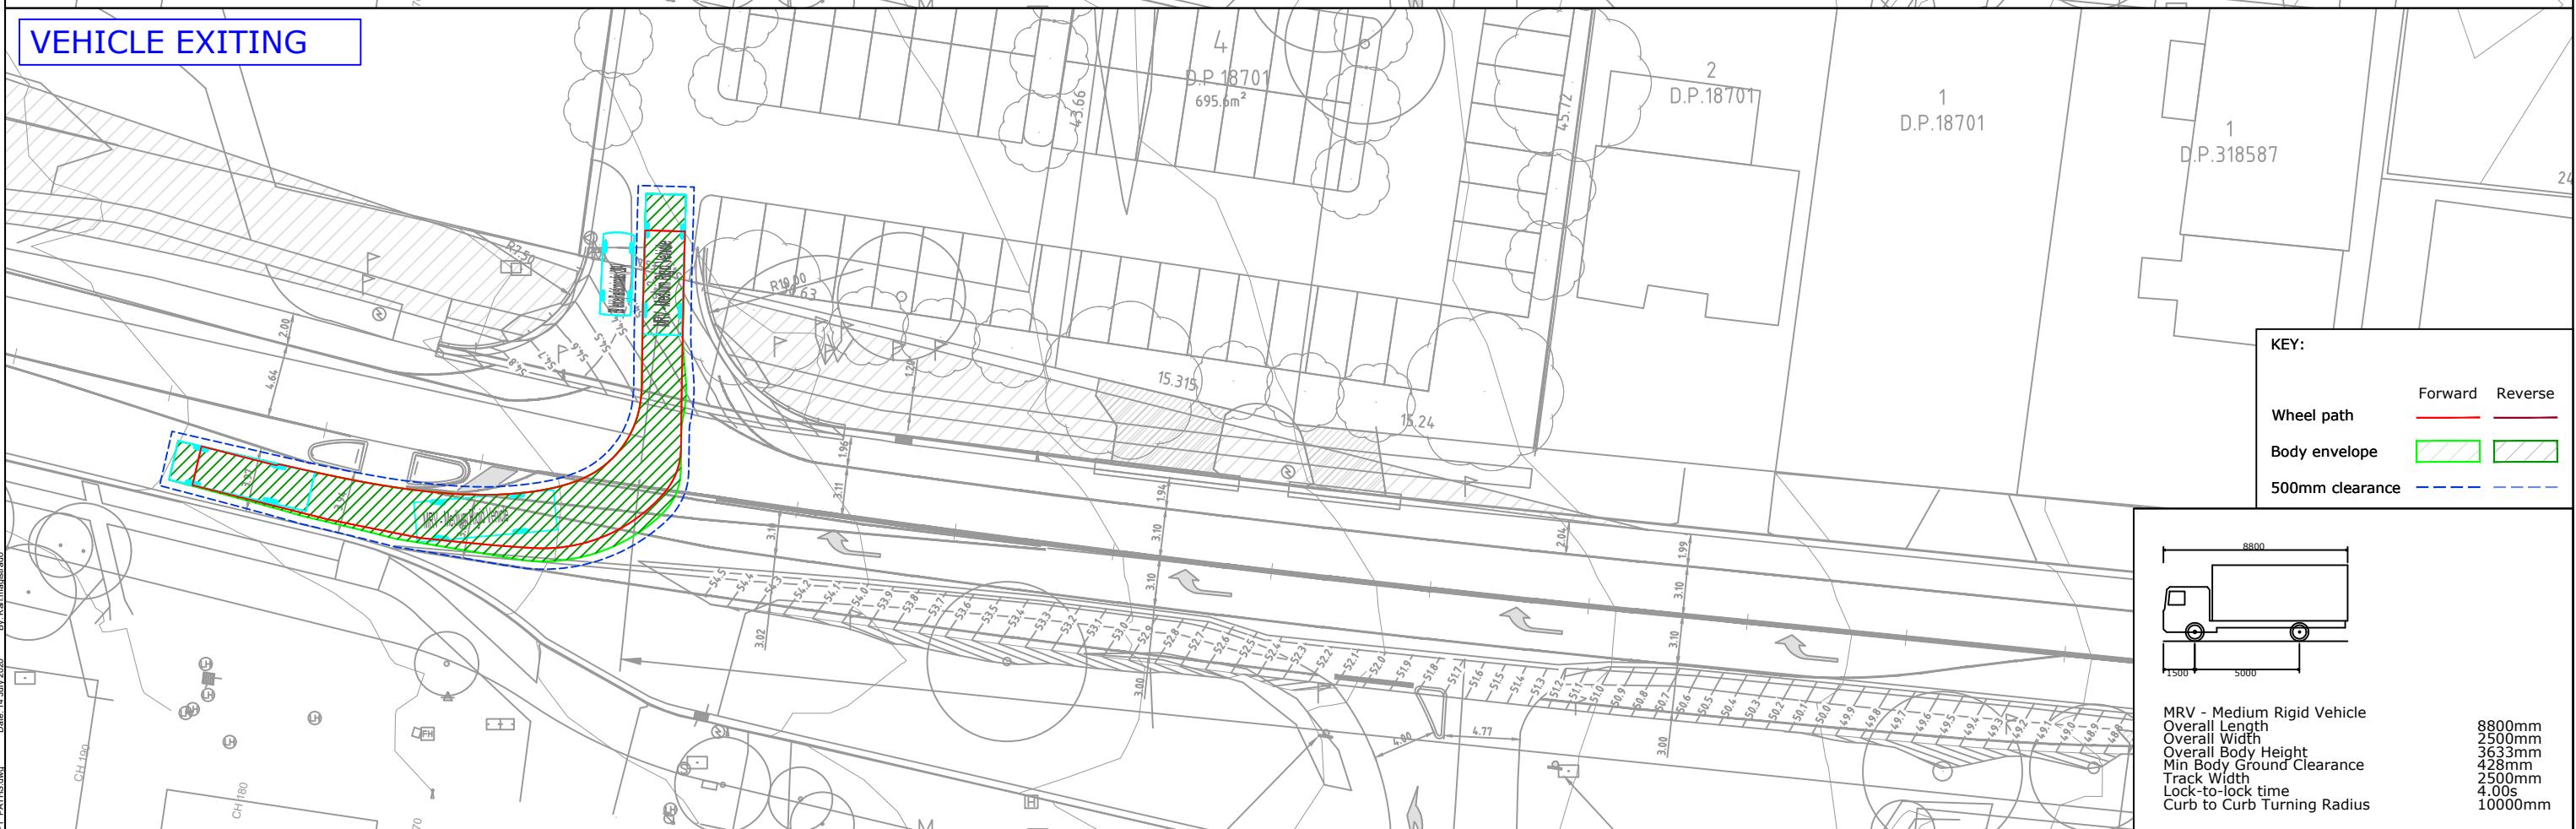

**KEY:**

Forward	Reverse
—	—
Body envelope	[Green Hatching]
500mm clearance	[Blue Dashed Line]

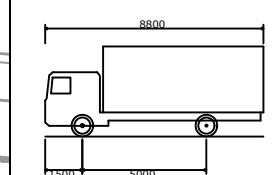

MRV - Medium Rigid Vehicle  
 Overall Length 8800mm  
 Overall Width 2500mm  
 Overall Body Height 3633mm  
 Min Body Ground Clearance 428mm  
 Track Width 2500mm  
 Lock-to-lock time 4.00s  
 Curb to Curb Turning Radius 1000mm

REV.	DESCRIPTION	DRAWN	CHECK	APP'D	DATE
A	ISSUE FOR DISCUSSION	KM	KH	KH	14/07/20



PROJECT

WALLACIA CROWN CEMETERY DEVELOPMENT

SWEPT PATH ANALYSIS  
 AS2890.2 8.8m MEDIUM RIGID VEHICLE - ENTRY DRIVEWAY (WALLACIA COUNTRY CLUB)


DWG No. 19529CAD006  
**FIGURE 1**  
 DATE STAMP 14 JULY 2020

PROJECT No. 19529    SCALE 1:400 @A3    REV. A

## VEHICLE ENTERING




## VEHICLE EXITING

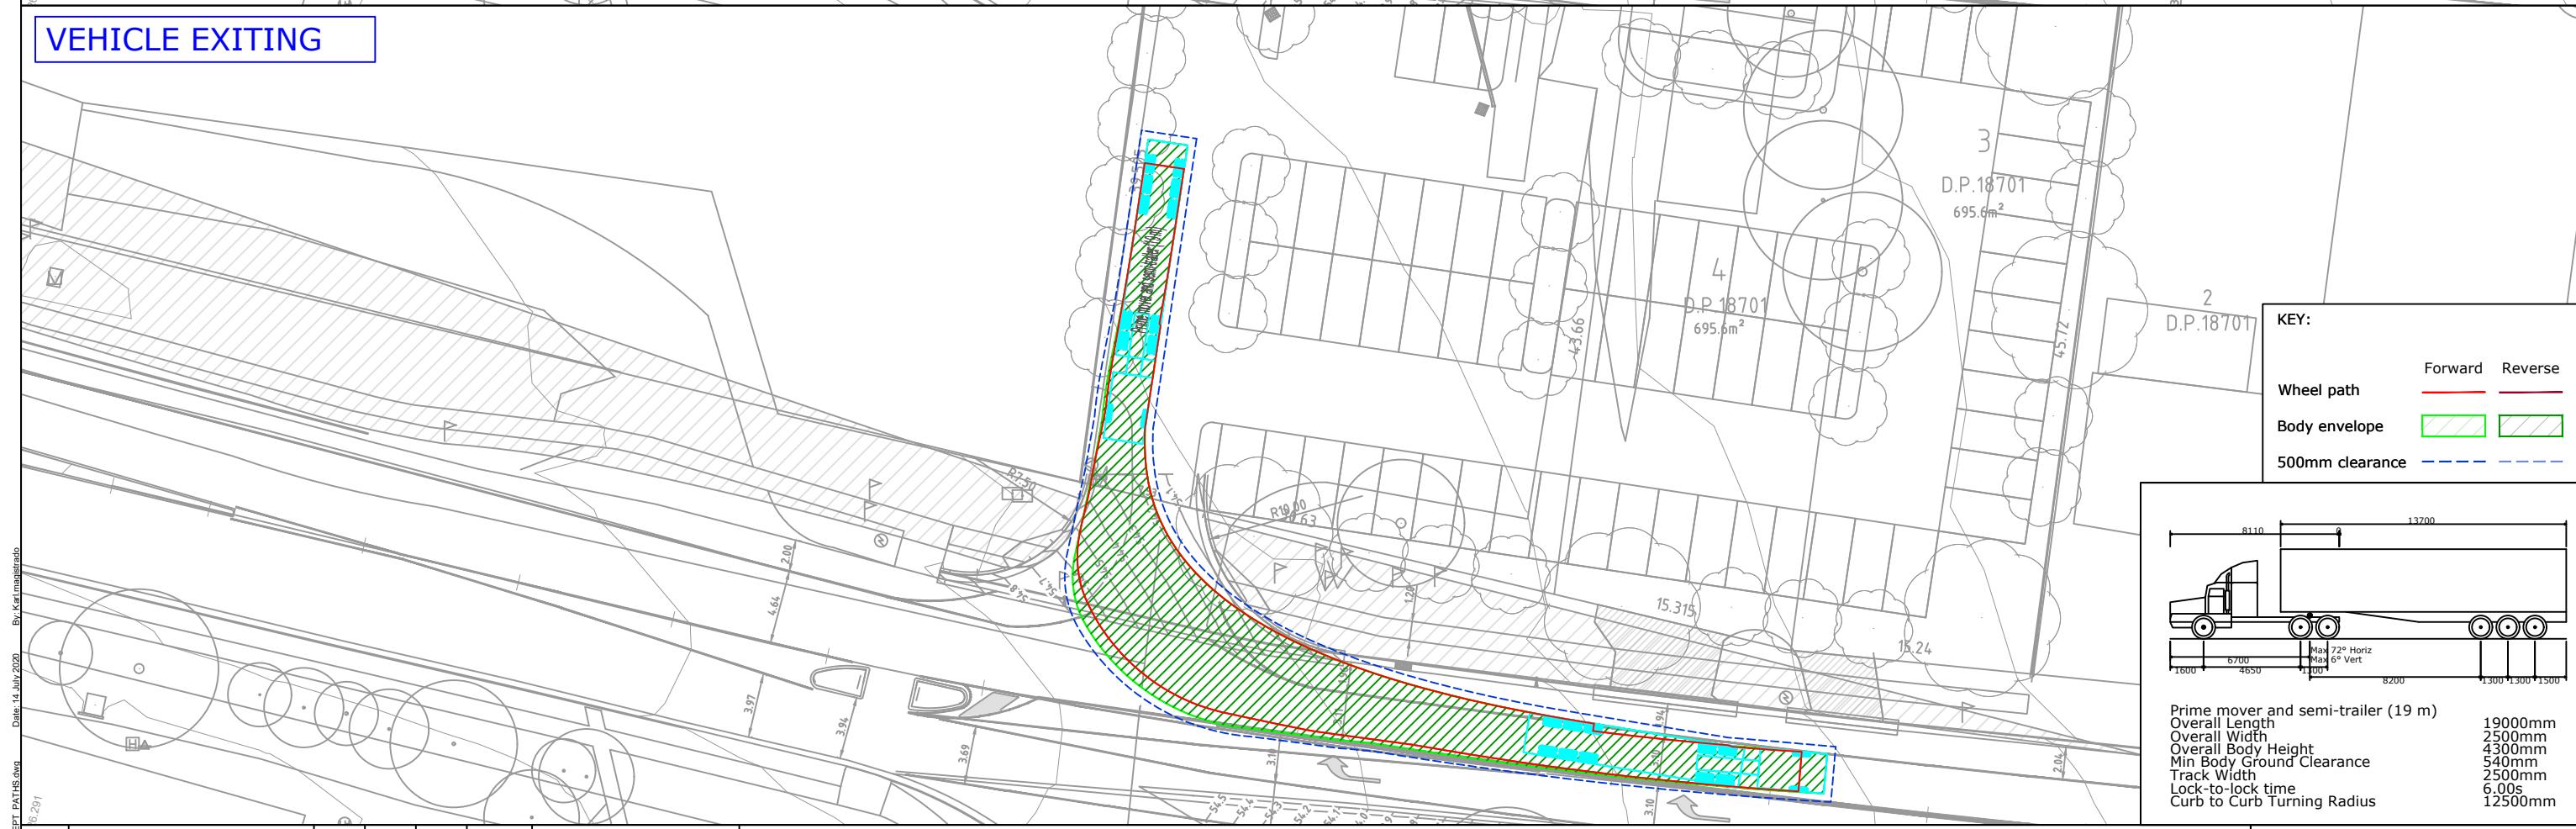


REV.	DESCRIPTION	DRAWN	CHECK	APP'D	DATE	PROJECT	DWG No.	FIGURE		
A	ISSUE FOR DISCUSSION	KM	KH	KH	14/07/20	WALLACIA CROWN CEMETERY DEVELOPMENT TITLE 19m PRIME MOVER & SEMI-TRAILER - ENTRY DRIVEWAY (WALLACIA COUNTRY CLUB)	DWG No. 19529CAD006 FIGURE 2 DATE STAMP 14 JULY 2020 PROJECT No. 19529 SCALE 1:400 @A3 REV. A			

## VEHICLE ENTERING

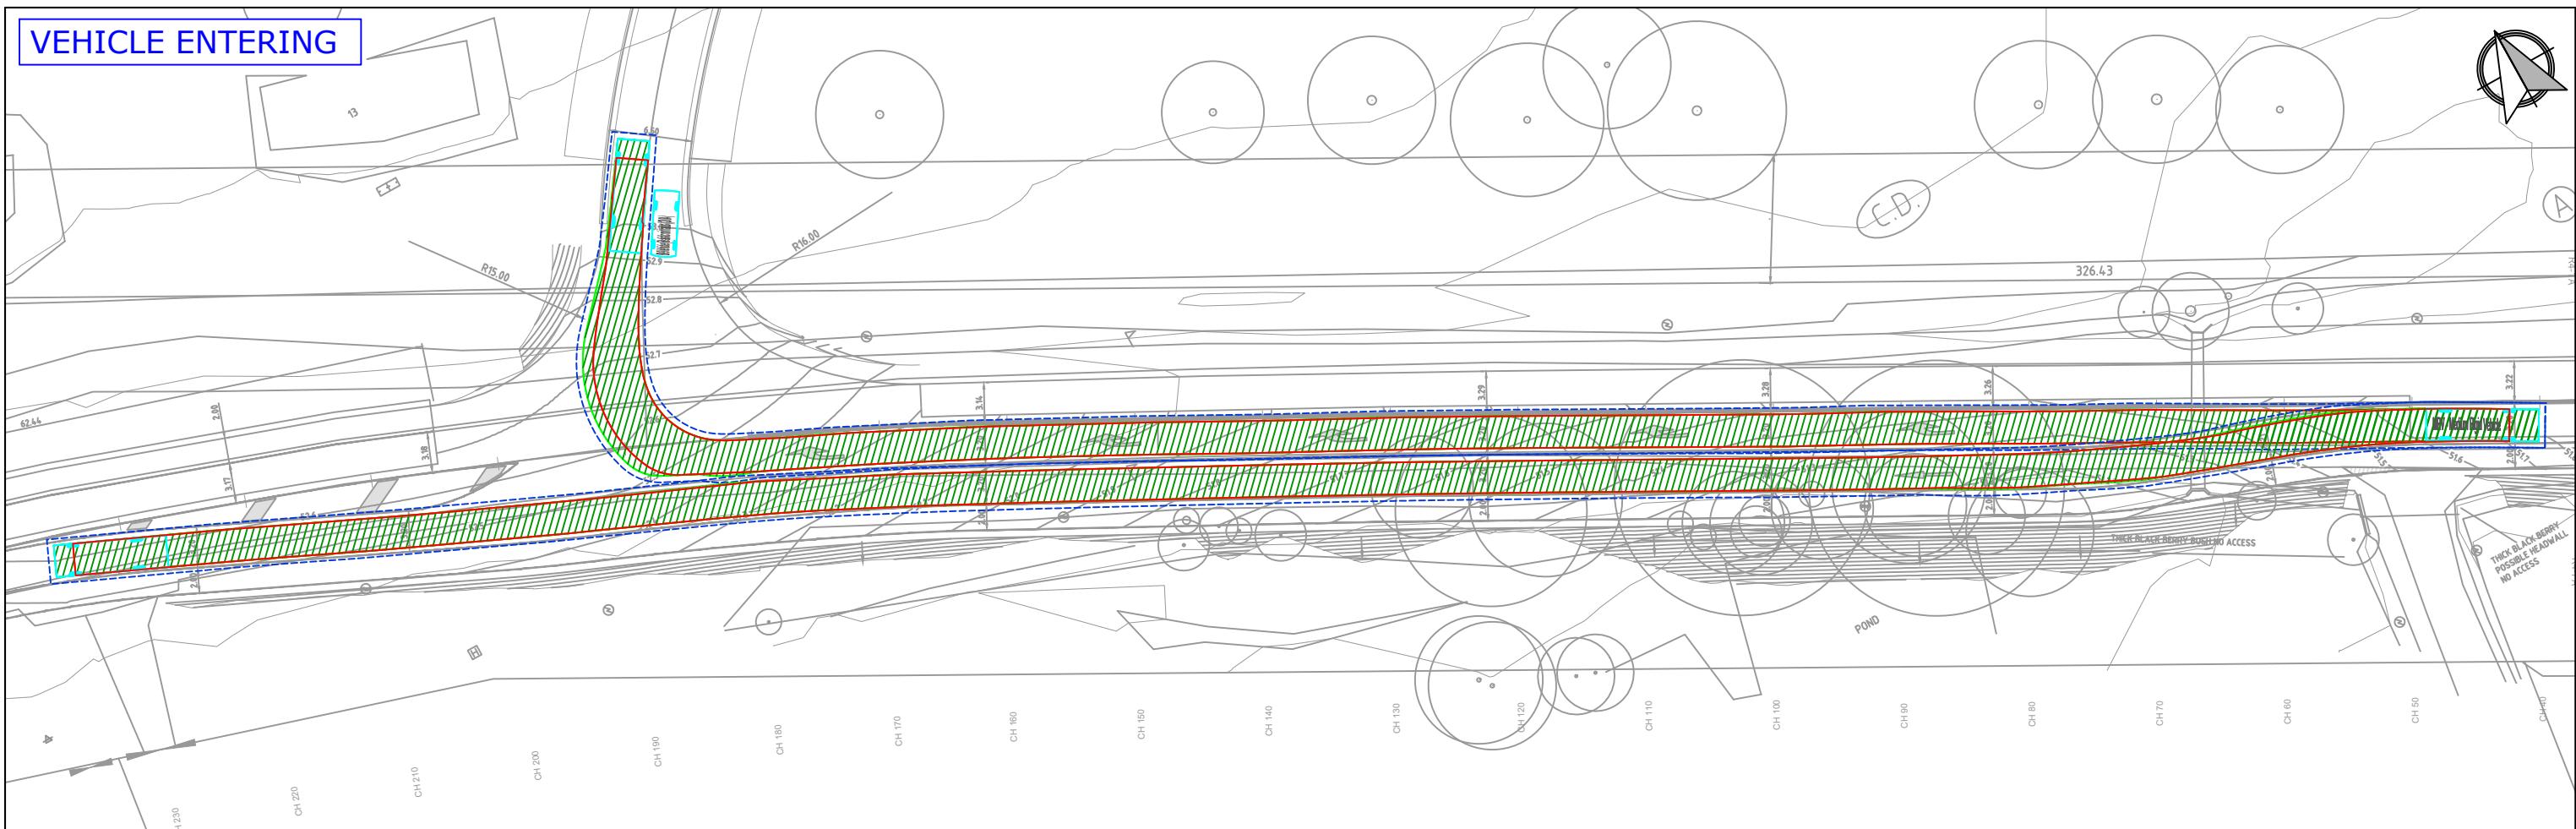


## VEHICLE EXITING

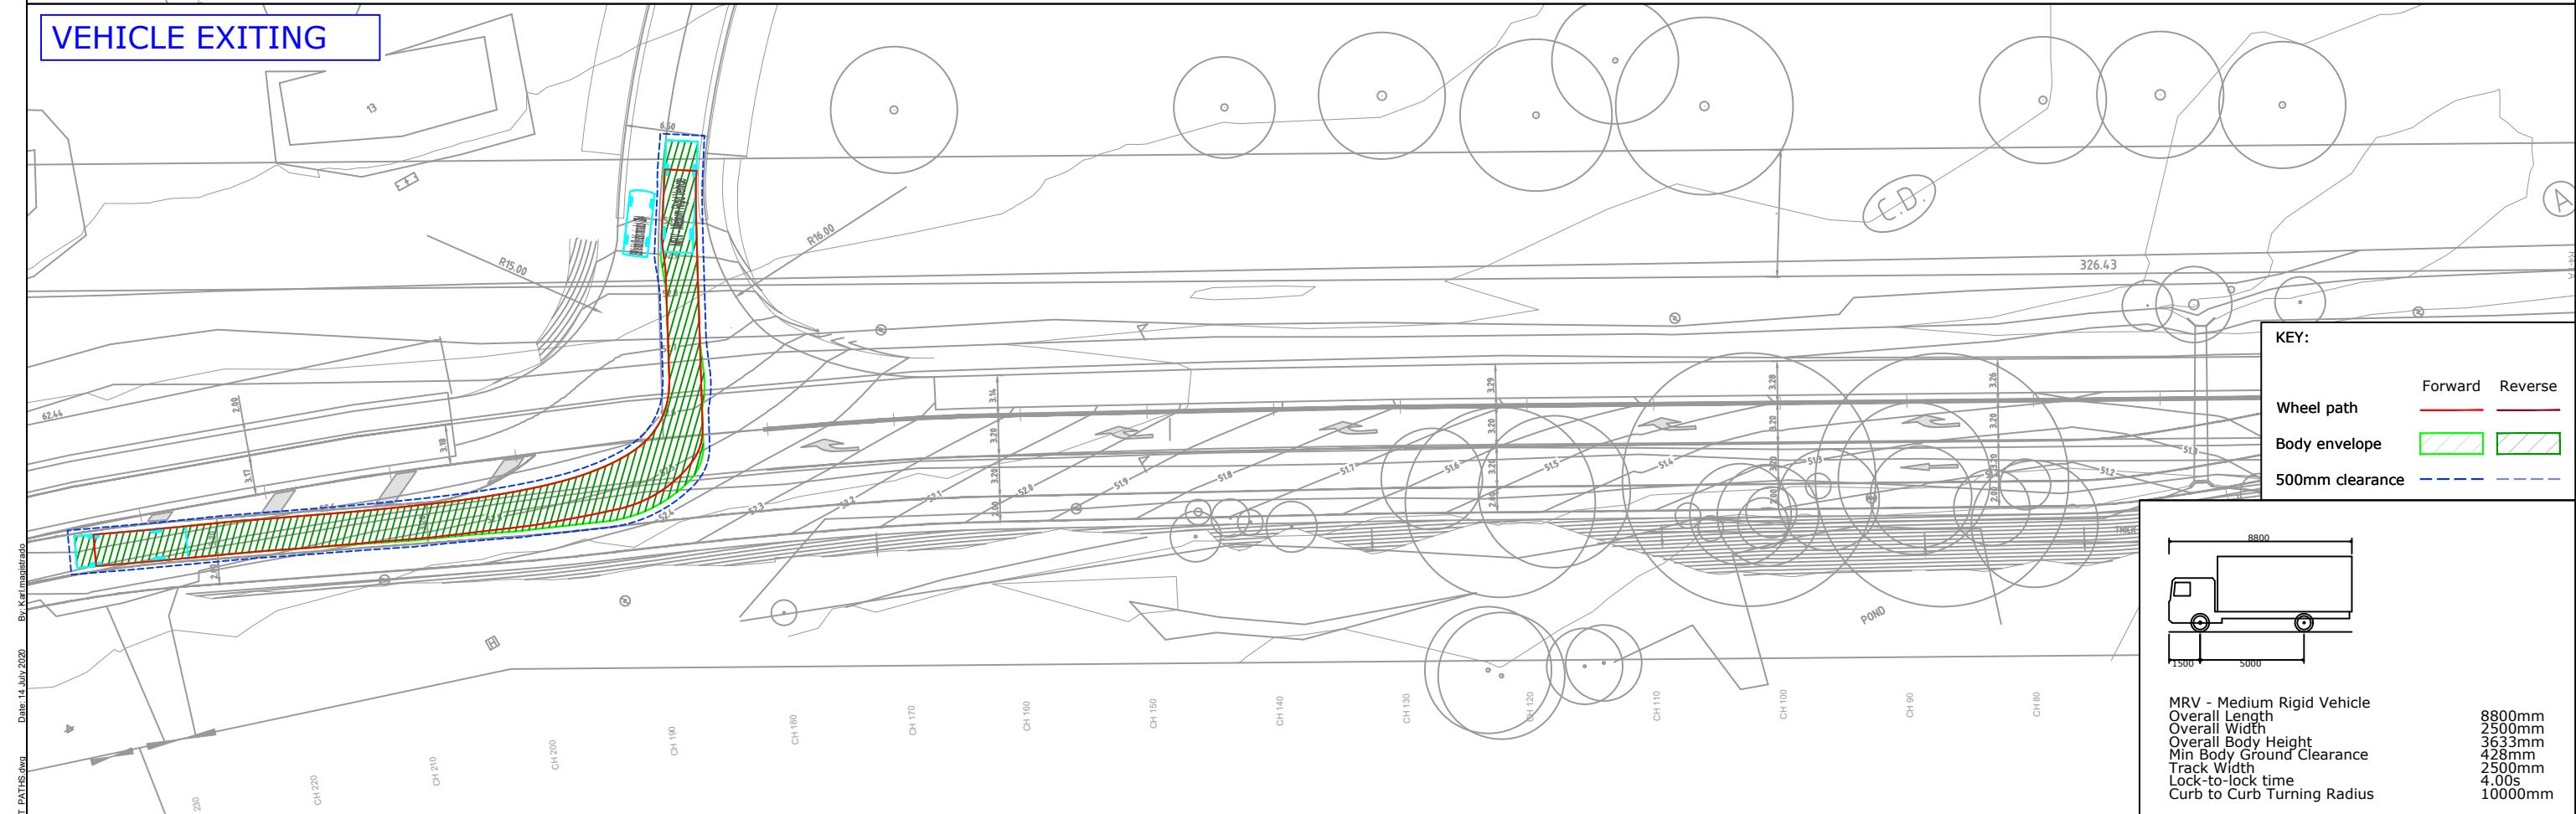

**KEY:**

Forward	Reverse
Body envelope	
500mm clearance	

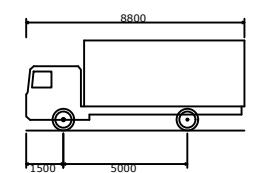

MRV - Medium Rigid Vehicle  
 Overall Length 8800mm  
 Overall Width 2500mm  
 Overall Body Height 3633mm  
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 Curb to Curb Turning Radius 1000mm

REV.	DESCRIPTION	DRAWN	CHECK	APP'D	DATE
A	ISSUE FOR DISCUSSION	KM	KH	KH	14/07/20

**ttpp**  
transport planning

PROJECT

WALLACIA CROWN CEMETERY DEVELOPMENT


SWEPT PATH ANALYSIS  
AS2890.2 8.8m MEDIUM RIGID VEHICLE - ENTRY DRIVEWAY (CAR PARK ROAD CEMETERY)

DWG No. 19529CAD006  
**FIGURE 3**


DATE STAMP  
14 JULY 2020

PROJECT No. 19529  
SCALE 1:500 @A3  
REV. A

### VEHICLE ENTERING

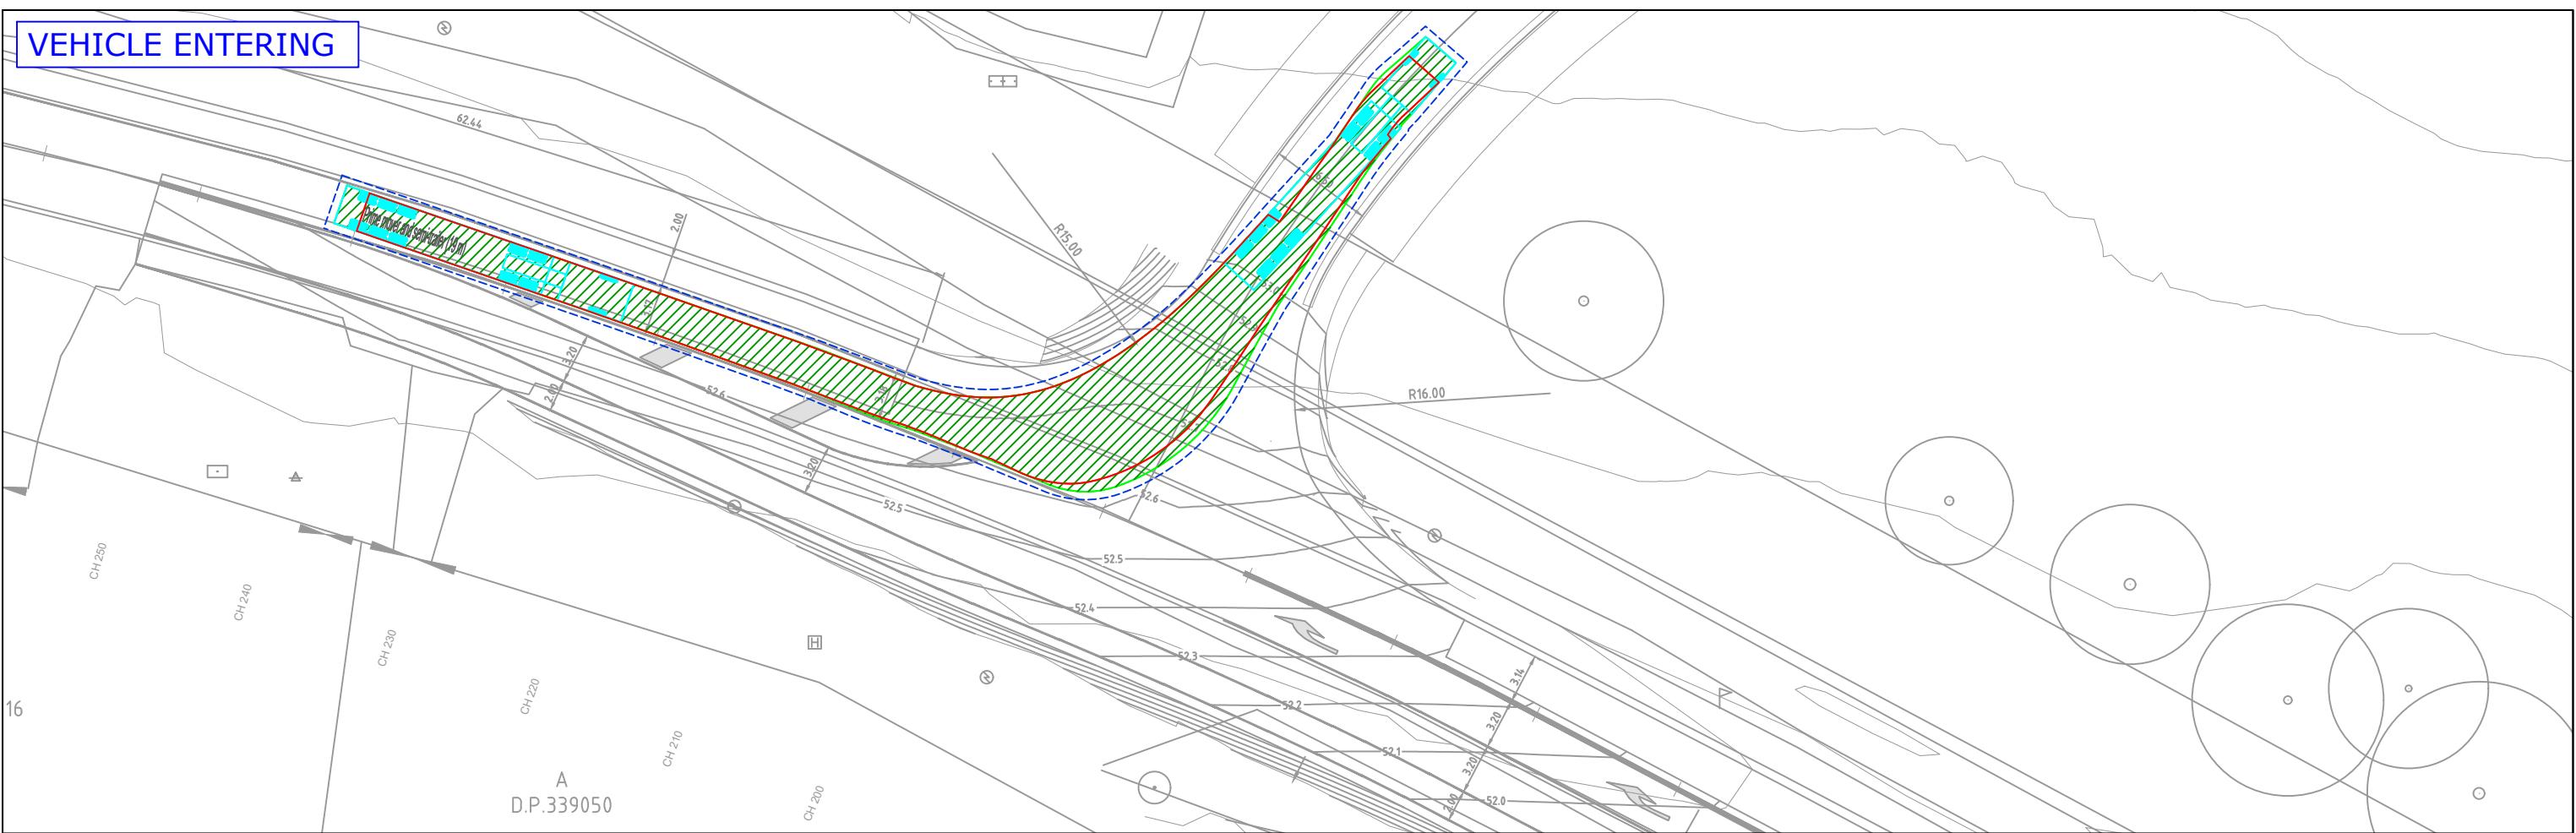

### VEHICLE EXITING

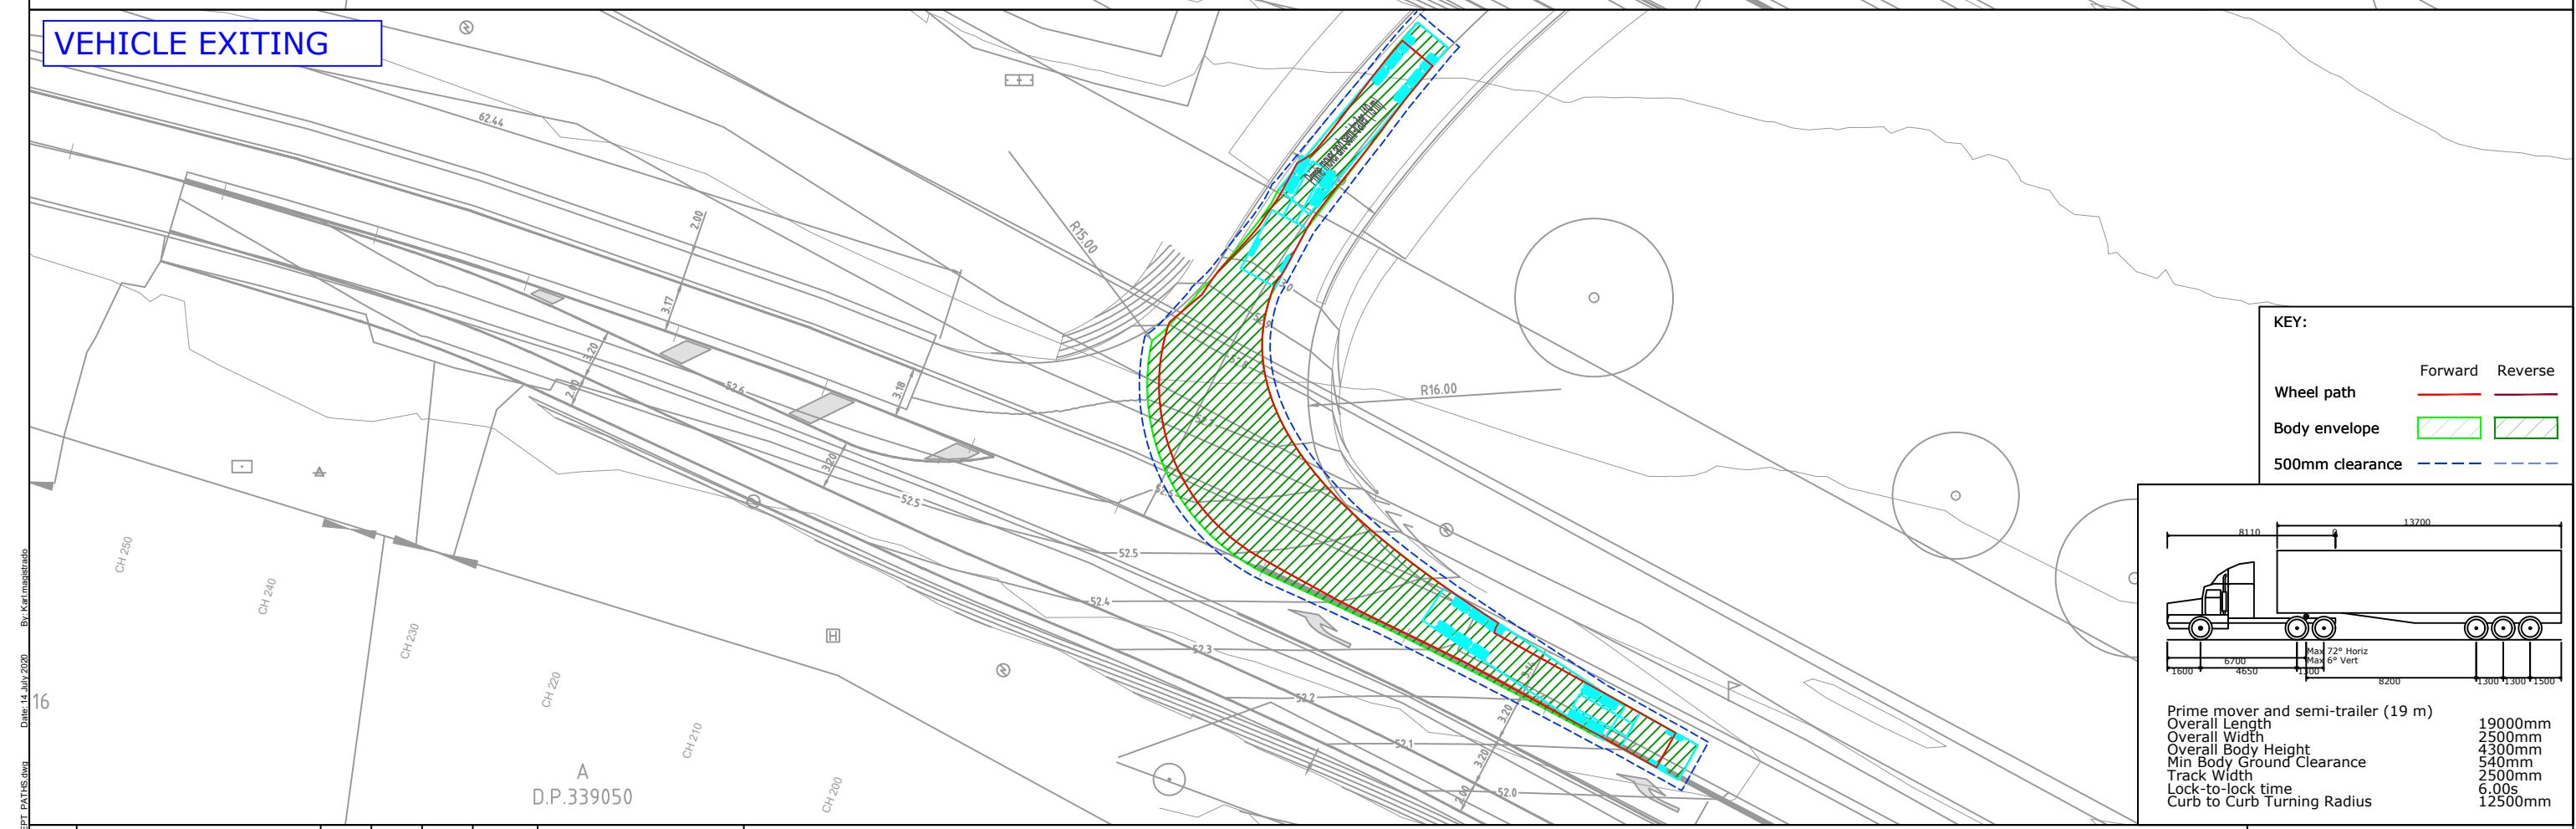

REV.	DESCRIPTION	DRAWN	CHECK	APP'D	DATE
A	ISSUE FOR DISCUSSION	KM	KH	KH	14/07/20



PROJECT

WALLACIA CROWN CEMETERY DEVELOPMENT

SWEPT PATH ANALYSIS  
19m PRIME MOVER & SEMI-TRAILER - ENTRY DRIVEWAY (CAR PARK ROAD CEMETERY)

DWG No. 19529CAD006  
FIGURE 4

DATE STAMP 14 JULY 2020

PROJECT No. 19529 SCALE 1:400 @A3 REV. A